F.A.P. R.T.E.	SECTION	COUNTY	TOTAL SHEETS	SHEET. NO.
	06-00199-00-LS	COOK	19	4
	LIGHTING	PLAN (1	OF 4)	
		ILLINOIS	630	4(

POLE PLACEMENT US RT 14 (MINER ST) STATION CIRCUIT POLE LABEL SETBACK* MC1 2.0' 0 + 492.0' 8.5 2 + 56MC2 2+96 Α MA2 4.0' 3+65 MB2 4.0' 3+65 MD2 2.0' 4+50 4.0' MA4 5+29 В MB4 4.0' 5+29 мс3 2.0' 6+17 MA5 4.0' 6+87 D MD3 3.0 7+53 С MC4 4.0' 7+79 MA7 4.0' 8+56 мв7 4.0' 4.0' 9+13 MA9 9+13 D MD4 2.0' 4.0' 9+65 MB10 10+43 Α MA10 5.0' *BACK OF CURB TO FACE OF POLE BASE

POLE PLACEMENT

US RT 12/45 (LEE ST)

MA6

MB8

MB6

MA8

MB9

*BACK OF CURB TO FACE OF POLE BASE

SETBACK*

2.0'

2.5

2.0'

2.0'

STATION CIRCUIT POLE LABEL

В

7+48

8+77

9+57

10+22

10+59

11 + 43

POLE PLACEMENT

US RT 12/45 (GRACELAND AVE)

MA1

*BACK OF CURB TO FACE OF POLE BASE

SETBACK*


4.0'


STATION CIRCUIT POLE LABEL

Α

1+20

0+96

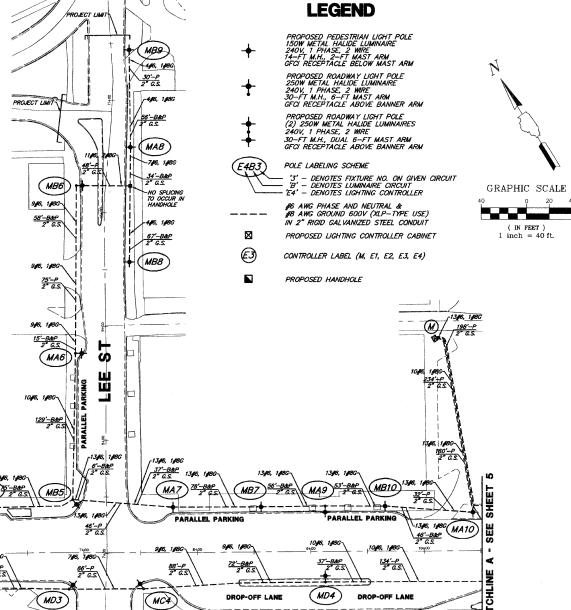

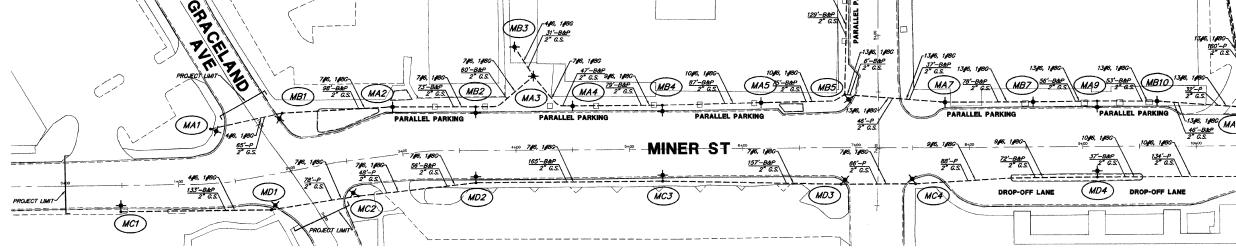

BENCH AND TRASH RECEPTACLE INSTALLATION NOTES: ALL PROPOSED BENCHES AND TRASH RECEPTACLES ARE TO BE INSTALLED AT LOCATIONS DESIGNATED AND

MARKED BY THE ENGINEER. MARKED BY THE ENGINEER.
2. PLACEMENT OF EACH BENCH AND TRASH RECEPTACLE
1S AS FOLLOWS:
6 - ALONG MINER STREET BETWEEN PEARSON
STREET AND LEE STREET
4 - ALONG OAKTON STREET BETWEEN WHITE STREET

AND U.S RT 12/45 (LEE STREET/MANNHEIM ROAD)

PLANS PREPARED BY:

GEWALT HAMILTON

ASSOCIATES, INC.

Consulting Engineers & Surveyors 850 Forest Edge Drive Vernon Hills, IL 60061 (847) 478-9700 (847) 478-9701 Fax

LIGHTING INSTALLATION NOTES:

1. ALL PROPOSED LIGHTING UNITS ARE REPLACEMENTS OF EXISTING UNITS IN THE SAME OR NEARBY LOCATION.

2. FOR ROADWAY LUMINAIRES MOUNTED ON COMBINATION FOR ROADWAY LUMINAIRES MOUNTED ON COMBINATION TRAFFIC SIGNAL MAST ARM ASSEMBLIES, REMOVAL ITEMS INCLUDE THE LUMINAIRE, MAST ARM AND WIRING TO POLE BASE. THE PROPOSED REPLACEMENT LIGHTING UNIT SHALL BE INSTALLED AS A SEPARATE POLE ADJACENT TO THE EXISTING TRAFFIC SIGNAL ASSEMBLY.

REVISIONS

DATE

NAME

CONDUIT INSTALLATION NOTES:

1. EXISITING CONDUIT THAT IS IN SUITABLE CONDITION FOR RE-USE, AS APPROVED BY THE ENGINEER, SHALL RE-MAIN IN PLACE AND BECOME PART OF THE REMAIN IN PLACE AND BELCOME PART OF THE PROPOSED LIGHTING SYSTEM INSTALLATION.
EXISTING CONDUIT THAT IS NOT IN SUITABLE CONDITION FOR RE-USE, AS APPROVED BY THE ENGINEER, SHALL BE ABANDONED IN PLACE, AND NEW CONDUIT SHALL BE INSTALLED AS SHOWN ON THE PLANS.

> ILLINOIS DEPARTMENT OF TRANSPORTATION LIGHTING PLAN (1 OF 4)

DES PLAINES LIGHTING IMPROVEMENTS AND STREETSCAPE DES PLAINES, ILLINOIS

SCALE: 1"=40' DATE: 8-14-2009

DRAWN BY: DRS DESIGNED BY: AJP CHECKED BY: BLS